

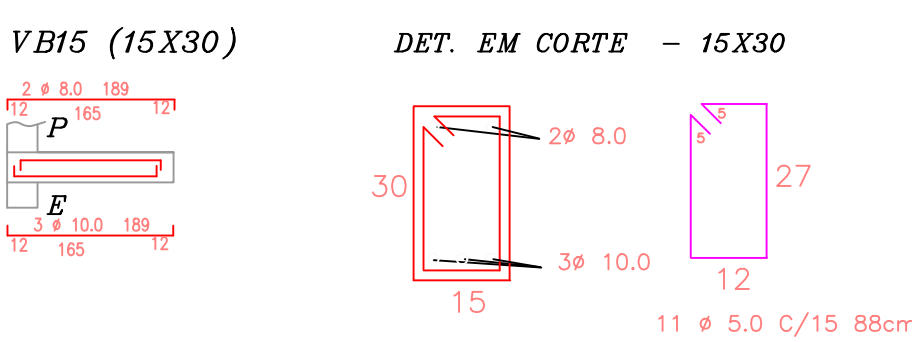
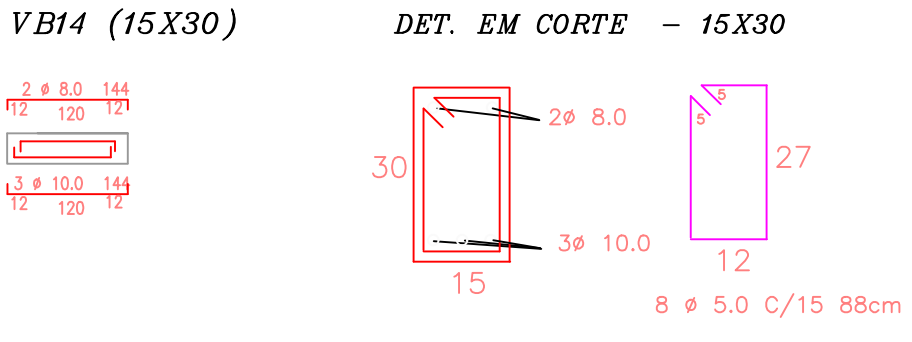
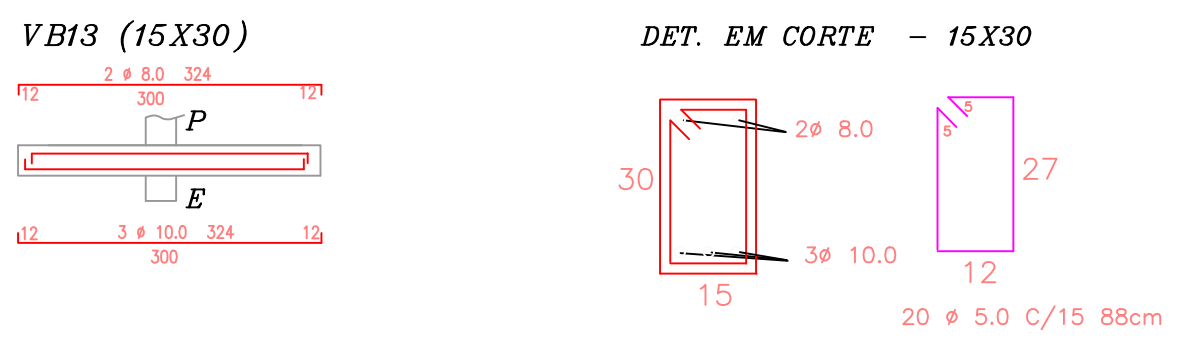
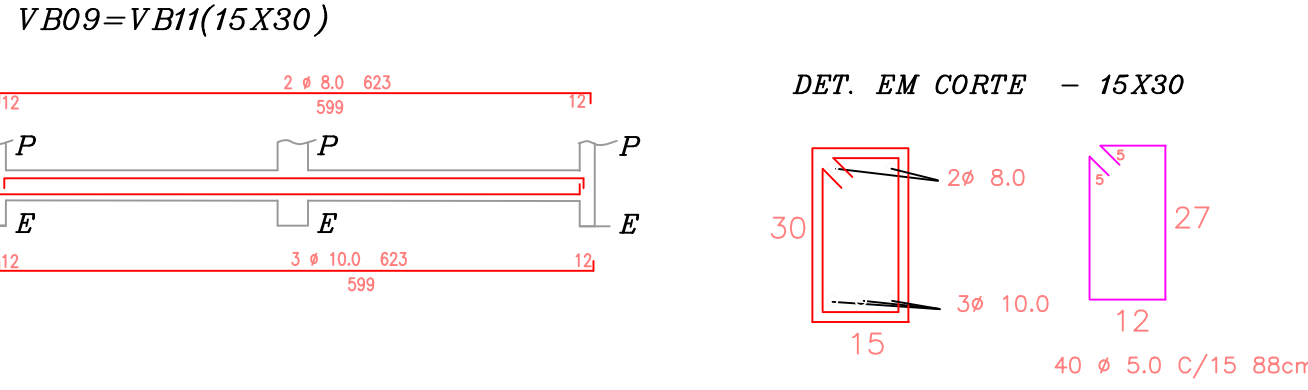
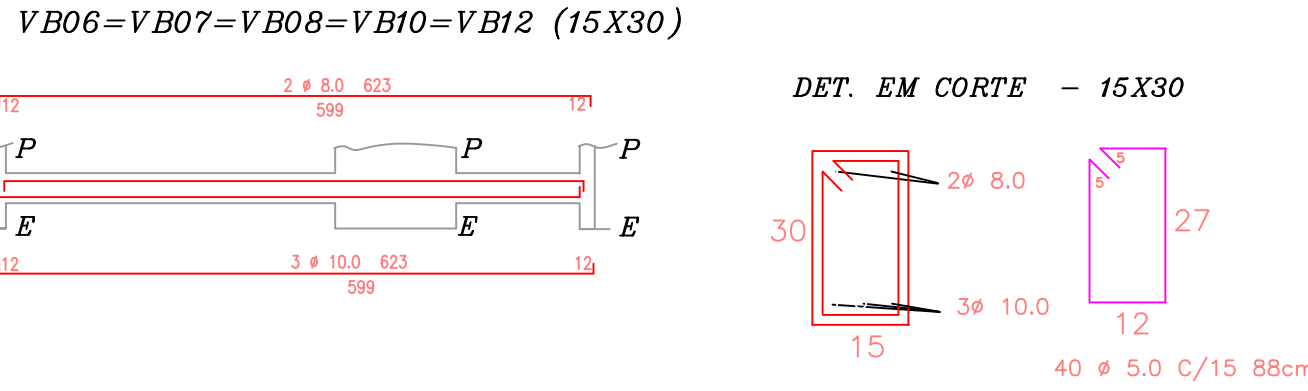
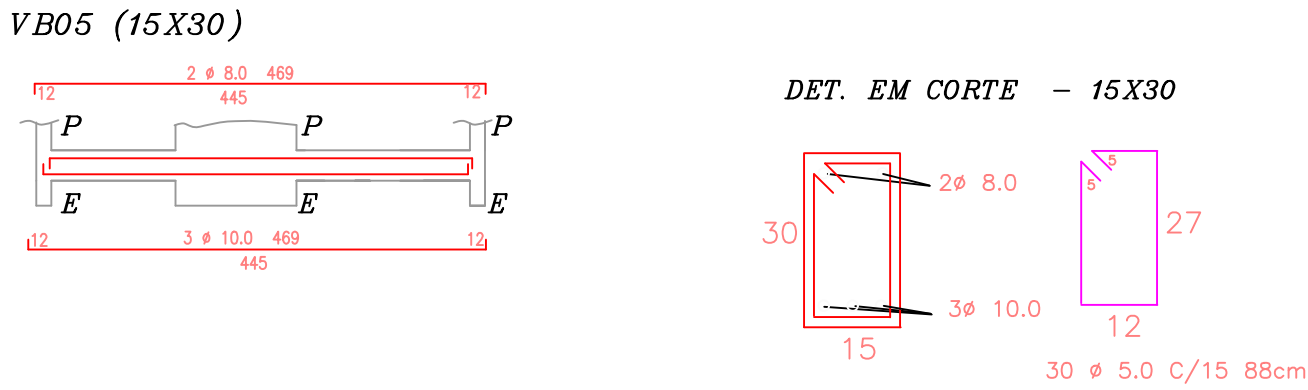
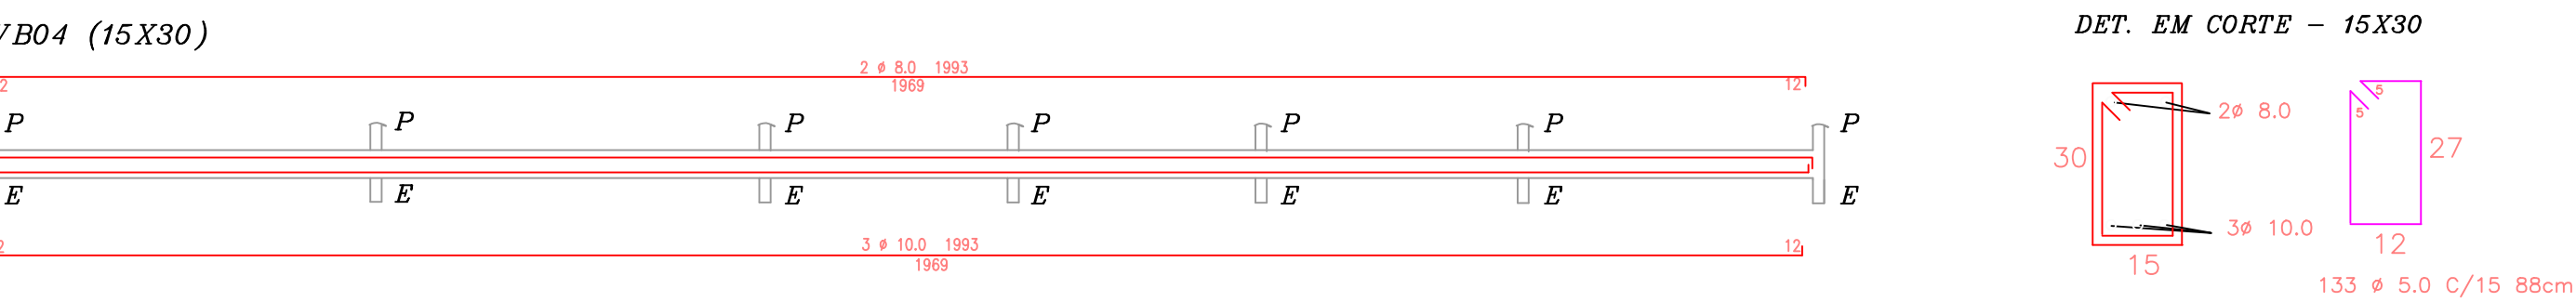
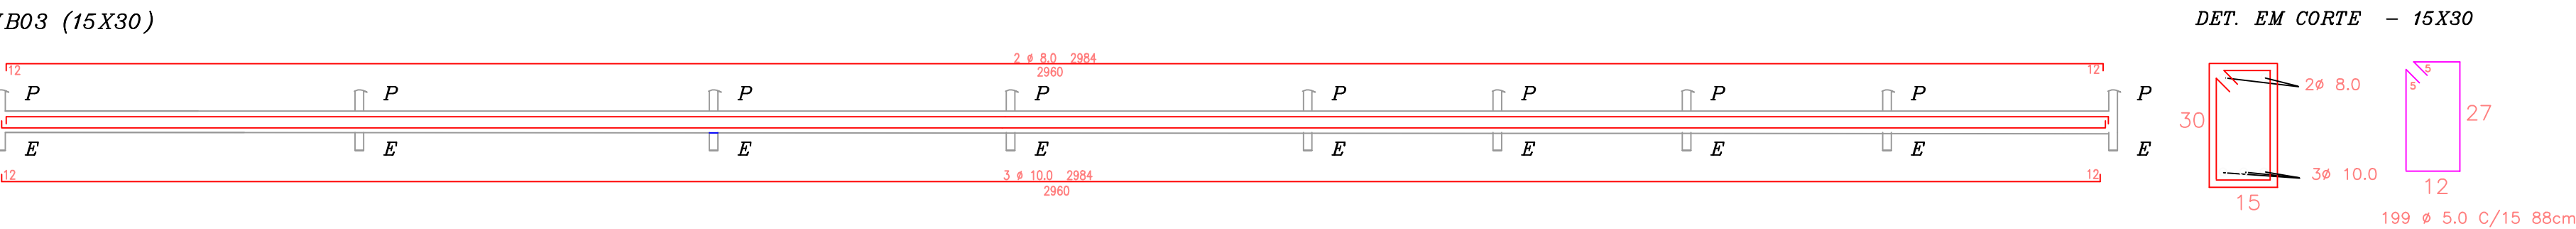
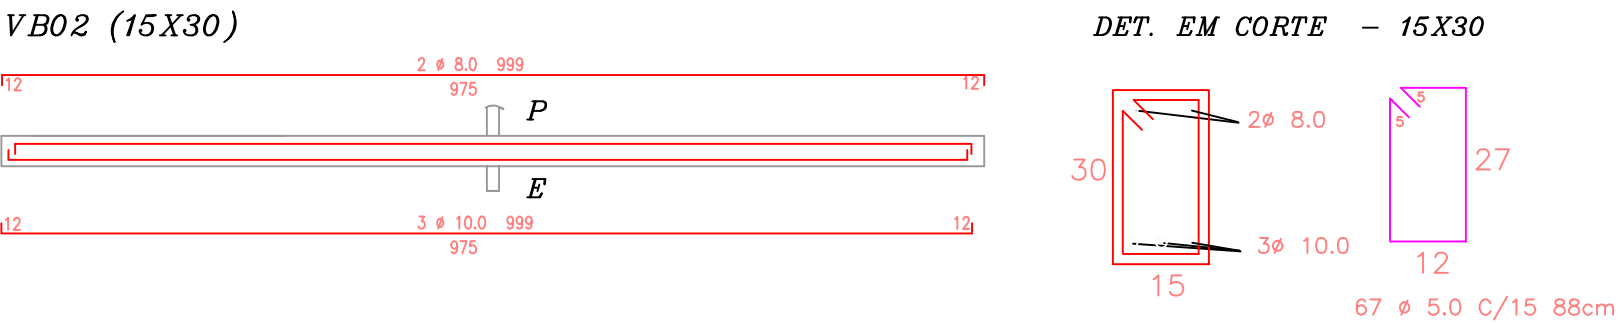


DETALHE DAS VIGAS BALDRAMES

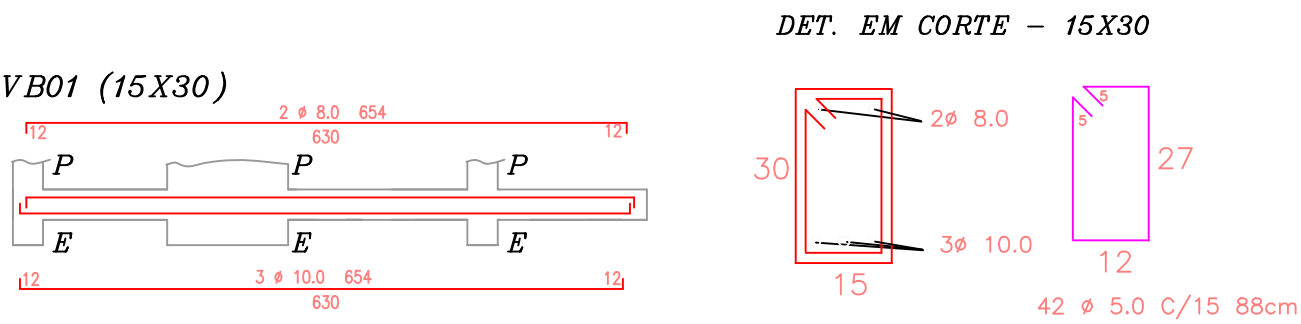

PARA VIGAS BALDRAMES	
Armação de Vigas Aço 5.0mm CA-60	129,31
Armação de Vigas Aço 8.0mm CA - 50	95,72
Armação de Vigas Aço 10.0mm CA - 50	224,29
Área de forma (m²):	70,54
Volume (m³):	5,29

DETALHES DAS VIGAS BALDRAMES

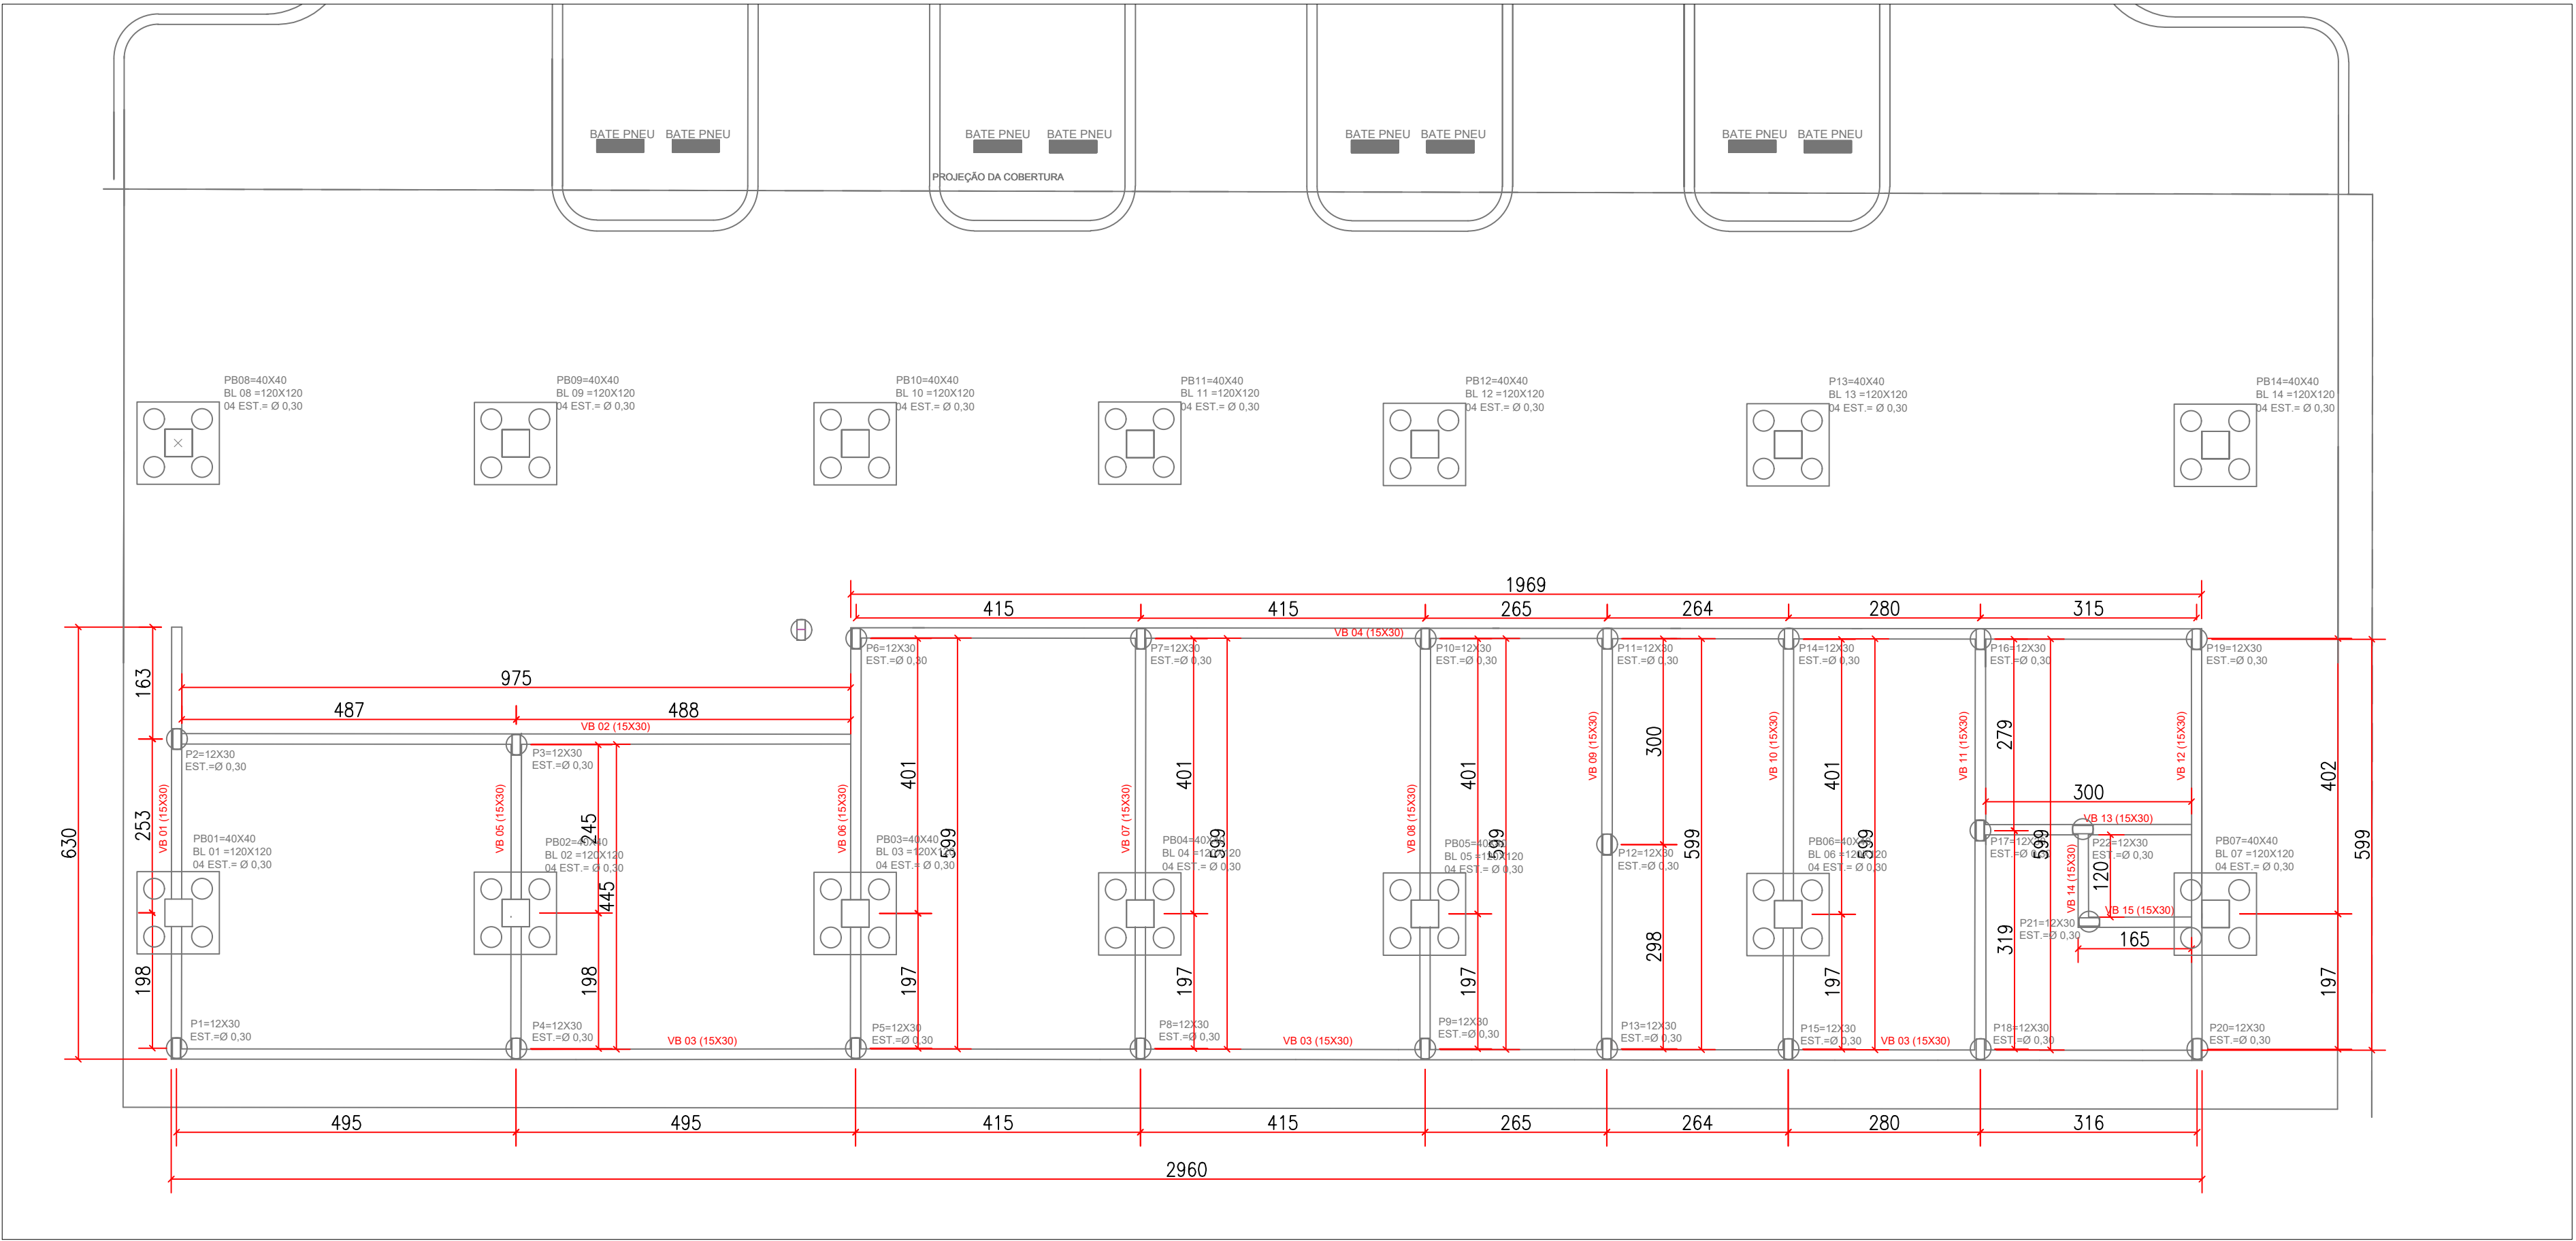

PLANTA BAIXA - VIGAS BALDRAMES

ESCALA 1:75

PROJETO FUNDAÇÃO
CONSTRUÇÃO DO TERMINAL RODOVIÁRIO
INACIOLÂNDIA - GO

FC
ENGENHARIA & CONSULTORIA EIRELI - ME
CNPJ: 26.435.399/0001-27
RUA C 236, S/N, QUADRA 552, LOTE 11, SALA 01 | CEP: 74.290-130
GOIÂNIA - GO

PROJETO APROVADO PELA PREFEITURA MUNICIPAL
EM : 30/10/2019

CONTEÚDO:
PLANTA BAIXA - VIGAS BALDRAMES
DETALHES

PROPRIETÁRIO:
PREFEITURA MUNICIPAL DE INACIOLÂNDIA
AUTOR DO PROJETO:
FERNANDO ANTÔNIO CERQUEIRA MACHADO
CREA: 14.058/D-BA
ENDEREÇO:
GO 206 ESQ. C/AV. 13 INACIOLANDIA - GO

ÁREA TOTAL DE CONSTRUÇÃO: 3.884,45 m²	ESCALA: INDICADA	DATA: AGOSTO/2020	FOLHA: 3 / 4
--	---------------------	----------------------	-----------------